Appendix 7-O

BEAR CREEK STREAM ALTERATION PERMIT



State of Utah DEPARTMENT OF NATURAL RESOURCES

DIVISION OF WATER RIGHTS

September 2, 1992

Governor Dee G. Hansen Executive Director Robert L. Morgan State Engineer 801-538-7240

1636 West North Temple, Suite 220 Salt Lake City, Utah 84116-3156

W J Owen Co Op Mining Company P O Box 1245 **Huntington UT 84528**

Stream Channel Alteration Permit Number 92-93-02SA to install a 60" culvert in Bear RE:

Creek.

EXPIRATION DATE: September 2, 1993

Gentlemen:

Your application to Alter Natural Stream Number 92-93-02SA is hereby approved pursuant to the requirements of Section 73-3-29 of the Utah Code Annotated, 1953. This approval also constitutes compliance with Section 404 (e) of the Clean Water Act (33 USC 1344) pursuant to General Permit 040 issued to the State of Utah by the U.S. Army Corps of Engineers on October 15, 1987.

Work performed under this permit is subject to the following conditions:

- Work should be accomplished during a period of low flow. Sediment introduced into 1. stream flows during construction must be controlled to prevent increases in turbidity downstream. This can be accomplished either by diverting flows away from the construction area or by constructing sediment control structures.
- Impacts to the stream channel and surrounding environment must be minimized. 2. Vegetation should not be destroyed, but if some disturbance is necessary, then revegetating with native species will be required, especially replacement of woody shrubs. The channel contours and configuration must not be changed.
- Riprap must only consist of clean, properly sized, angular rock. Riprap must be keyed 3. deeply into the streambed to prevent undercutting. A filter should be placed behind riprap if necessary (i.e. soils are fine grained, non-cohesive, and erodible). Material such as bricks, concrete, or other demolition debris or refuse will not be allowed.
- Wet cement is toxic to aquatic organisms, and its introduction into waters of the 4. United States would constitute a violation of the Clean Water Act. Wet cement or concrete may not be allowed to enter stream flows. Water must be excluded from areas where concrete or cement is used until it has set. Contaminated water pumped from the construction area may not be discharged in a manner to allow it to enter flows. Equipment used during this type of work must be washed well away from the channel.

Page 2 Co-Op Mining Company September 2, 1992

Within 30 days after the completion of this project, the State Engineer's office must be contacted for a compliance inspection. Failure to provide such notification would invalidate U. S. Army Corps of Engineers General Permit 040, thereby placing the applicant in violation of Section 404 of the Clean Water Act.

Arrangements for this compliance may be made through either of the contacts listed below:

Jim Wells Mark Page

Division of Water Rights/Dam Safety Regional Engineer

This Decision is subject to the provisions of Rule R655-6 of the Division of Water Rights and to Sections 63-46b-13 and 73-3-14 of the Utah Code Annotated, 1953 as amended, which provide for filling either a Request for Reconsideration with the State Engineer, or an appeal with the appropriate District Court. A Request for Reconsideration is not a prerequisite for a court appeal. A court appeal must be filed within 30 days after the date of this Decision, or if a Request for Reconsideration has been filed, within 30 days after the date the Request for Reconsideration is denied. A request for Reconsideration is considered denied when no action is taken 20 days after the Request is filed.

If you have any questions or need further clarification, please feel free to contact Jim Wells at 538-7374.

Sincerely,

Robert L. Morgan, P.E.

State Engineer

RLM/jw/sh

pc: Brooks Carter - Corps of Engineers

Bob Mairley - EPA

Bob Freeman - U. S. Fish & Wildlife

Jim Dykman - State History Carolyn Wright - State Planning Mark Page - Regional Engineer

Ken Phippen - Regional Wildlife Habitat Manager

Habitat Manager - Wildlife Resources


PERMIT APPLICATION


TO ALTER A NATURAL CHANNEL IN THE STATE OF UTAH

1			Application	Number	92-	93-0254
Applicant's Name (Last, First		Autho	rized Agent		Telephon	e No. & Area Code
Co-Op Mining Compa	-		J. Owen			
Address (Street, RFD, Box Nu	mber, City, State,	Zip)		·	<u> [801] 3</u>	81-2450
	untington,	Utah	84528			
Ouarter Section(s)	Section(s)		Township(s)	<u> </u>	Range(s) 8	Raco
ent, nut	Sec. 25		T16S		R7E	SLB&M
County Waterco	ourse to be altere	d	<u> </u>		Drainage	
Emery County	Bear Cre	ek				
Common Description or Addre				<u>-</u>	Bear	Canyon
Bear Canyon	•		Mine			
2 Nature of proposed alteration	(Check applicable	e hoves)				
	erevace		bridge	XX.u	lleger*	
	onstruct ealign		riprap channel	☐ we	etland	
	namain Ostream structure	· · · 🗇	diversion works		struction Hercourse	
3 Failmaind Cost of Project	Tradition Structure		Project Plans	<u> </u>	her	
s \$10,000.00 to 2	0.000.00	3	,			
5 Brief Explanation of Project		Pl	ans included? y	es Numbe	r of attachm	ents THREE
·						
Install 50" Culvert, Bank with riprap in	Approx. 30	0 line	ar feet, in	Bear C	reek. [Reinforce
	area or a	Srobos	ed sealment	pona o	utlet.	
	:					
•						
6 Instification (Explain why this	project is needed	1				
1. Build new faci		,				
Salla new Edel	ricies					
	,					
7 Detrimental Effects (Anticipate unavoidabl	d changes to the	water and	telated land reso	urces inclu	Idina	
unavoidabi	e detrimental effi	ects)	1000	aroos, mora	iding	
Incidental increase detrimental effects	e in distur s.	bed a	rea. No ap	parent :	long-ter	m ·
	¥					




9 Names and addresses of adjoining property owners, lesseds, etc. COP Development Co. 3140 South Main Street Salt Lake City, Utah 84115 10 Schooling Starting Date of Propert Estimated Completion Date of Project July 1992 September, 1992 percentage of the State of Utah. If approved, this work will be done in accordance with conditions of approved agree and after a part of the best of my knowledge. Signature of tweet or Authorized Agent. FOR OFFICE USE ONLY Resommended to be of the Area Engineer. Approved Reject. Area Engineer. Area Engineer. Date Date	8 Alternatives (other alternatives to the proposed ac	tion!
COP Development Co. 3140 South Main Street Salt Lake City, Utah 84115 10 Spanied Startine Date of Project July 1992 September, 1992 a make inake application persuant to 157.29. Praisonde Aniestated, 1955, and all other supporting rules for a persuant attraction and other information submitted with this application. The information submitted and statements made care rules this application are true and correct to the best of my howledge. Shouth of Owner or Authorized Agent FOR OFFICE USE ONLY Recommendations of the Area Engineer Approve Reserve	Maintain the status quo	
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September, 1992 note the make application pursuant to 19729. Utals Code Annotated, 1955, and all other supporting rules for a perpendiculation actual the State of Utals. If approved, this work will be done in accordance with conditions of approval, supporting rapes, class, and other information submitted with this application. The information submitted and statements made enceraint this application are true and carrect to the best of my knowledge. Signature of Owner or Authorized Agent. Date FOR OFFICE USE ONLY Resonanced to the Area Engineer. Approve Reject.	3140 South Main Street	115
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Bother make application pursuant to 10.7.29. Utali Code Aniestated, 1955, and all other supporting rules for a permat treatural themselin the State of Utah. If approved, this work will be done in accordance with conditions of approval, supporting ages, makes and other information submitted with this application. The information submitted and statements made encerning this application are true and correct to the best of my knowledge. Signature of Owner or Authorized Agent. Date FOR OFFICE USE ONLY Resonanced ations of the Area Engineer. Approve Reies:	10 Is smalled Starting Date to Project	Estimated Completion Date of Project
noted make application pursuant to 73.7-29. Utais Code Annotated, 1955, and all other supporting rules for a percent matter atural, honnel in the State of Utah. If approved, this work will be done in accordance with conditions of approval, supporting subsidered and statements made encountry. The information submitted and statements made encountry this application are true and correct to the best of my knowledge. Signature of Owner or Authorized Agent. Date FOR OFFICE USE ONLY Resonanced tions of the Area Engineer. Approve Release.	July 1992	
supporting and other information submitted with this application. The information submitted and statements made once this application are true and correct to the best of my knowledge. Signature of Owner or Authorized Agent Date		
Recommende nons of the Area Engineer Approve Reion:		Signature of Owner or Authorized Agent Date
Recommende nons of the Area Engineer Approve Reion:	FOR	OFFICE USE ONLY
Area Engineer Date		
Date		
		Area Engineer

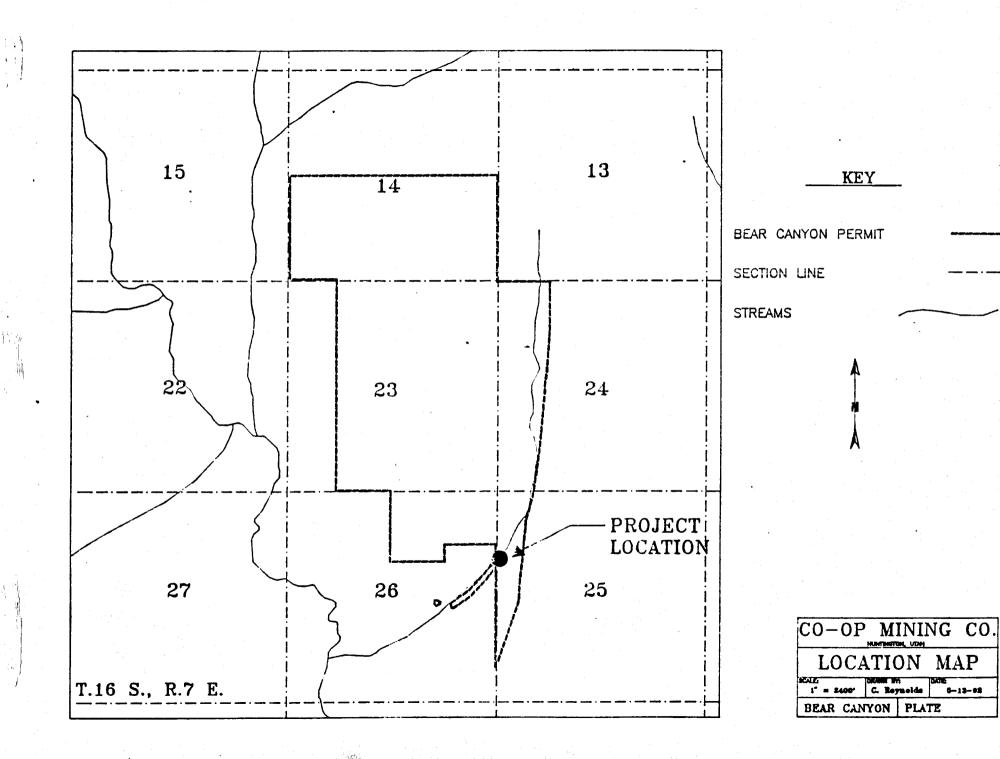

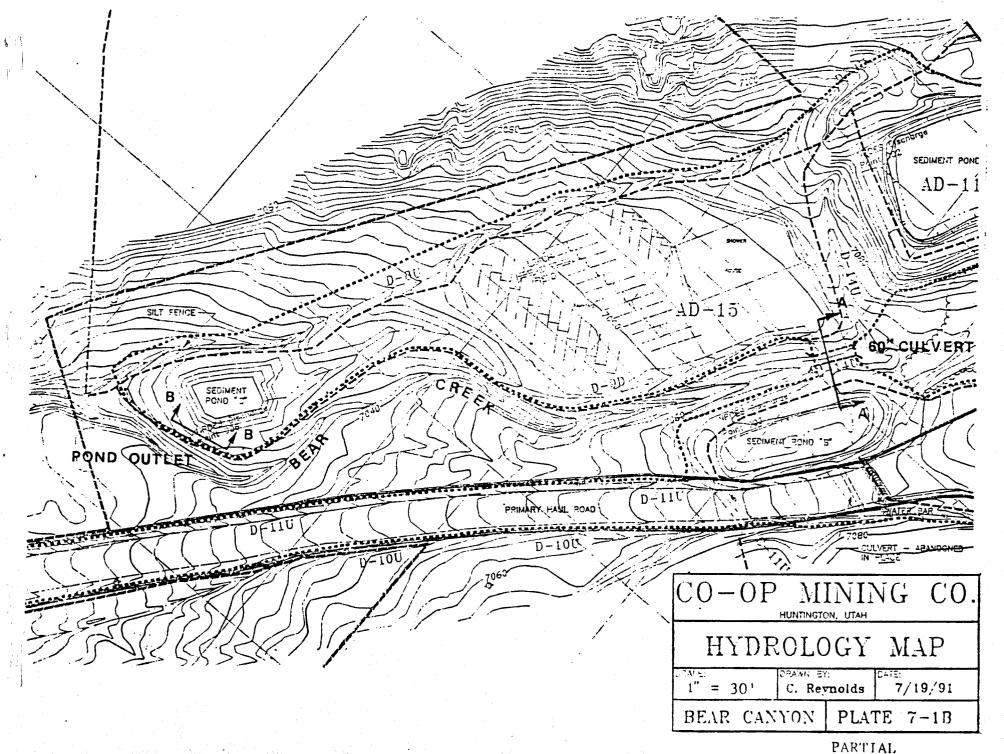


CO-OP Mining Company
Bear Canyon Mine
Proposed Bear Creek Culvert
and sediment pond outlet
Cross-Sections



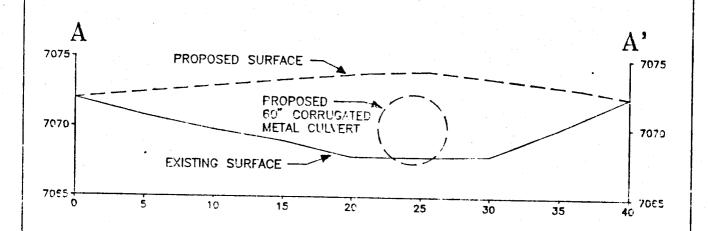

SECTION B-B'

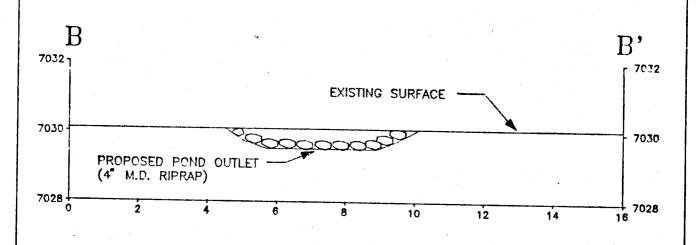

JOINT PERMIT APPLICATION FORM

U. S. ARMY CORPS OF ENGINEERS - FOR SECTIONS 404 AND 10 UTAH STATE ENGINEER'S OFFICE - FOR NATURAL STREAM CHANNELS

(Assigned by:) C	огрѕ			. /	Stat	e Engineer	
Applicant's Name (Last, First M.I.)		Authori	zed Agen	t		Telephone N	umber and Area Code
Co-Op Mining Company			Charles Reynolds			(435) 687-2450	
Applicant's Address (Street, RFD, Box Number, City, State, Zip)							
P. O. Box 1245, Huntington,	Utah, 8	4528					
<u></u>	PRC	DECT LO	OCATIO	1			
Quarter Section(s) $A = NW \frac{1}{4}$	Section $A = 2$,	Township		Rar	nge	Base & Meridian
B + SW/4 = C.D.E.F = SE/4	B,C,D,E,F = 24		T	16 S		7 E	SLBM
County	Watercourse to be a	altered	Check one: ——Wi			city limits _	Cutside city limits
Emery	Bear Creek, Rt	. Fork I	Orain.	List town or	nearest to	wn: Huntir	gton
Project location or address:							
Bear Canyon Mine, Bear Ca	nyon						
Brief description of project:							
93-93-09SA). Also to culvert 5 lefor road crossing and pad area co		ight Fo	rk inter	mittent an	d ephen	neral chani	nels to provide
Purpose (justification) of project:							
To expand mining operations into	o the right fork c	anyon f	or the	ourpose of	mining	the Wild I	lorse Ridge
coal leases	•	•	-	•		*	
Is this a single and complete project or is it project or other related activities. This is a single project, but it is a							olease describe the larger
							<u> </u>
It project includes the discharge of dredged or fill material:							
							,
Cubic vards of material: N/A							
Acreage or square footage of war	ters of the United Sta	tes, includ	ding wetla	ands, affected	by the pro	oject:	
				•			
Source and type of fill material:				ar .			

Alternatives (other ways to accomplish the project purpose):	
None	
Names and addresses of adjacent property owners or other individual	s who may be affected by this project:
C.O.P. Coal Development Company 3212 Sout State St.	(Surface Landowner)
Salt lake City, Utah 84115	
Approval from the Utah State Division of Oil, Gas & Application currently under review. DOGM approvaresolution of additional technical deficiency issues.	al pending approval of Stream Alteration permit &
Estimated starting date of project	Estimated completion date
7-01-00	9-01-01
Application is hereby made for a permit or permits to authorize the ac	
I hereby certify that	is acting as my agent for this project.

INSTRUCTIONS


Applications which do not include the following will not be processed.


For a complete application, you MUST include the following on 8 1/2 by 11 paper (for large projects, multiple sheets with a key may be used). Clear, hand-drawn plans approximately to scale are acceptable.


1. An accurate location map (USGS quadrangle map preferred)

Agent's address and telephone number


- 2. A plan view of the proposed activity (as seen from above) including dimensions of work.
- 3. A cross-section view of the proposed activity (may use typical cross-section for large projects) including dimensions
- 4 For projects which include wetlands, an accurate wetland delineation must be prepared in accordance with the current method required by the Corps.

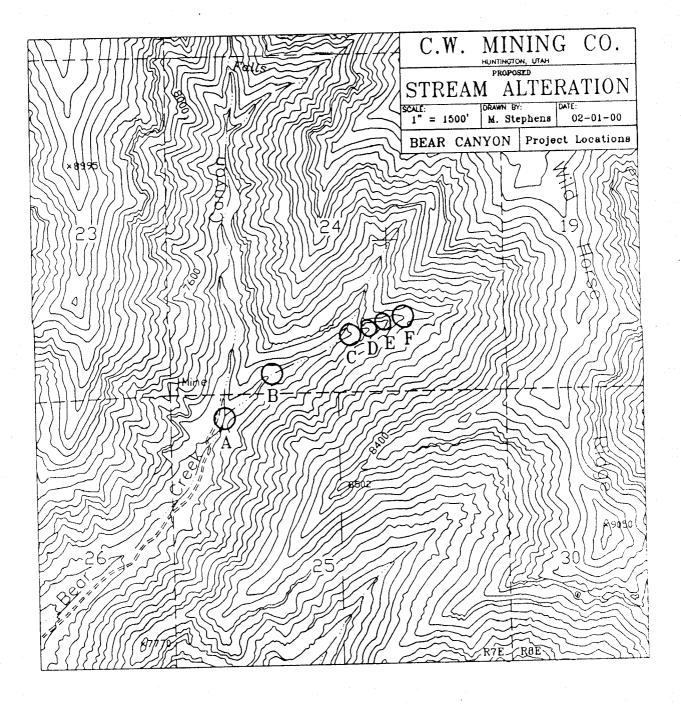

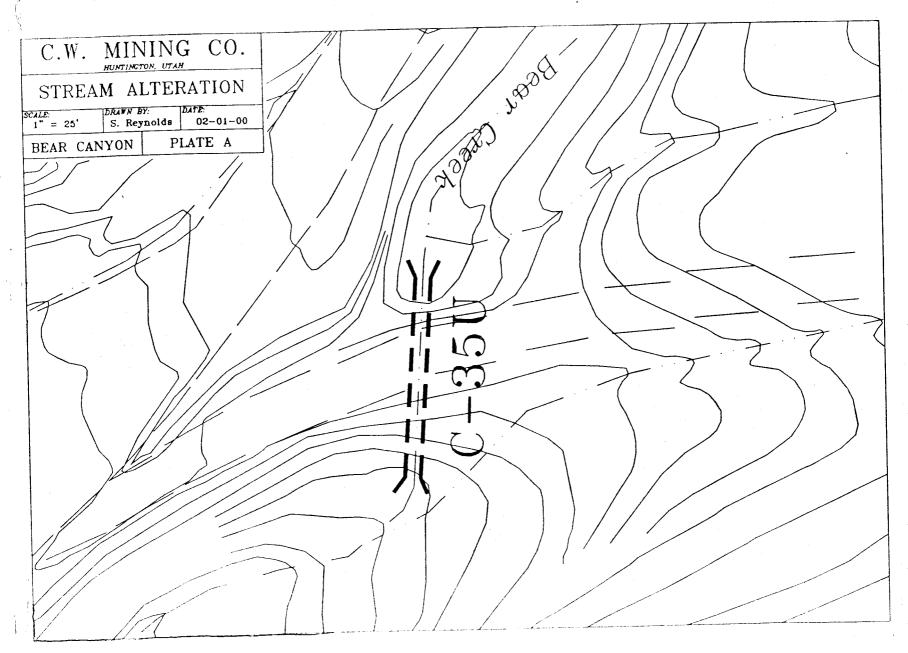


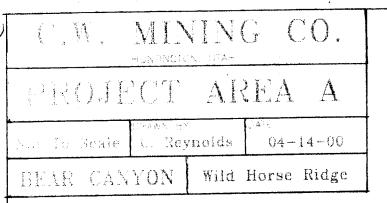

Inlet

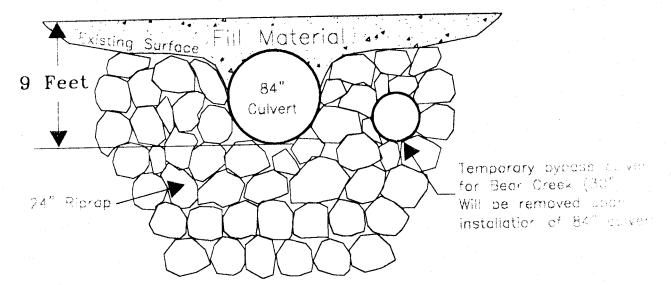

Outlet

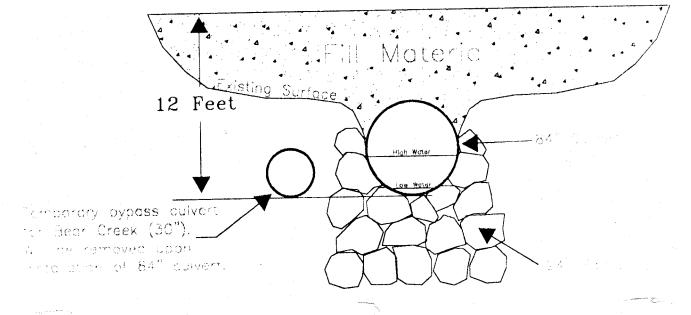

Circular Channel Analysis & Design Solved with Manning's Equation

Open Channel - Uniform flow

Worksheet Name: CULVERT C-35U

Comment: SEE PLATE 7-1F

Solve For Actual Depth

Given Input Data:

 Diameter.....
 5.00 ft

 Slope.....
 0.0600 ft/ft

 Manning's n.....
 0.024

Discharge...... 108.18 cfs


Computed Results:

Percent Full..... 38.43 % Full Capacity.... 345.56 cfs OMAX @.94D...... 371.72 cfs

Froude Number.... 2.29 (flow is Supercritical)


Minimum required riprap conditions = 24" m.d. riprap at outlet

Open Channel Flow Module, Version 3.3 (c) 1991 Haestad Methods, Inc. * 37 Brookside Rd * Waterbur

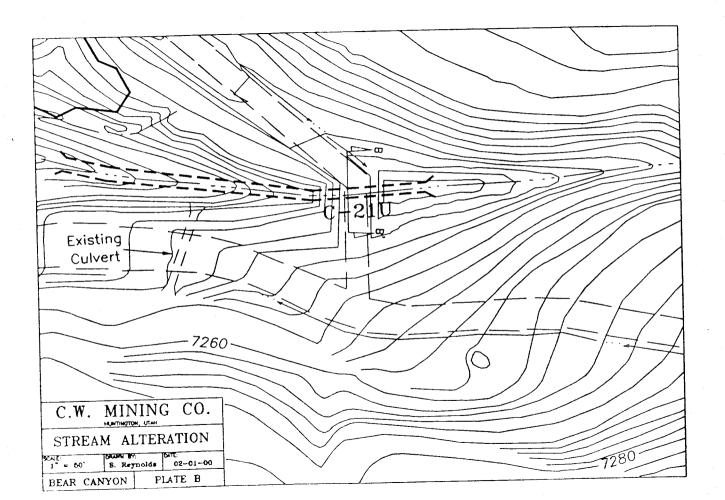

C.W. MINING CO. HUNTINGTON, UTAH PROJECT AREA B CALE: DRAWN BY: M. Stephens DATE: 02-01-00 BEAR CANYON Wild Horse Ridge

CROSS-SECTION VIEW B-B'

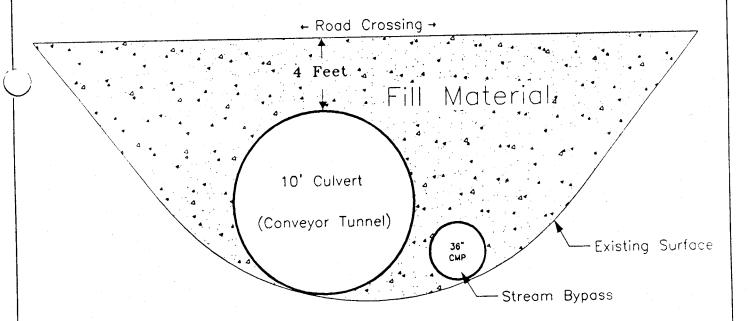

Note: Flow In Channel Is Ephemeral

Circular Channel Analysis & Design Solved with Manning's Equation

Open Channel - Uniform flow

Worksheet Name: C-21U

Comment: SEE PLATE 7-1F

Solve For Actual Depth

Given Input Data:

 Diameter
 3.00 ft

 Slope
 0.0600 ft/ft

 Manning's n
 0.024

 Discharge
 43.09 cfs


Computed Results:


Full Capacity.... 88.50 cfs OMAX @ 94D..... 95.20 cfs

Froude Number.... 2.04 (flow is Supercritical)

Minimum required riprap conditions = 12" m.d. riprap at outlet

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Circular Channel Analysis & Design Solved with Manning's Equation

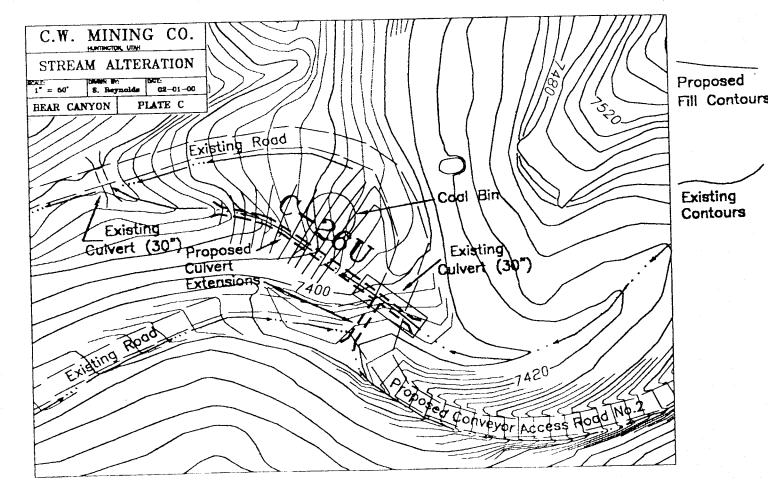Open Channel - Uniform flow

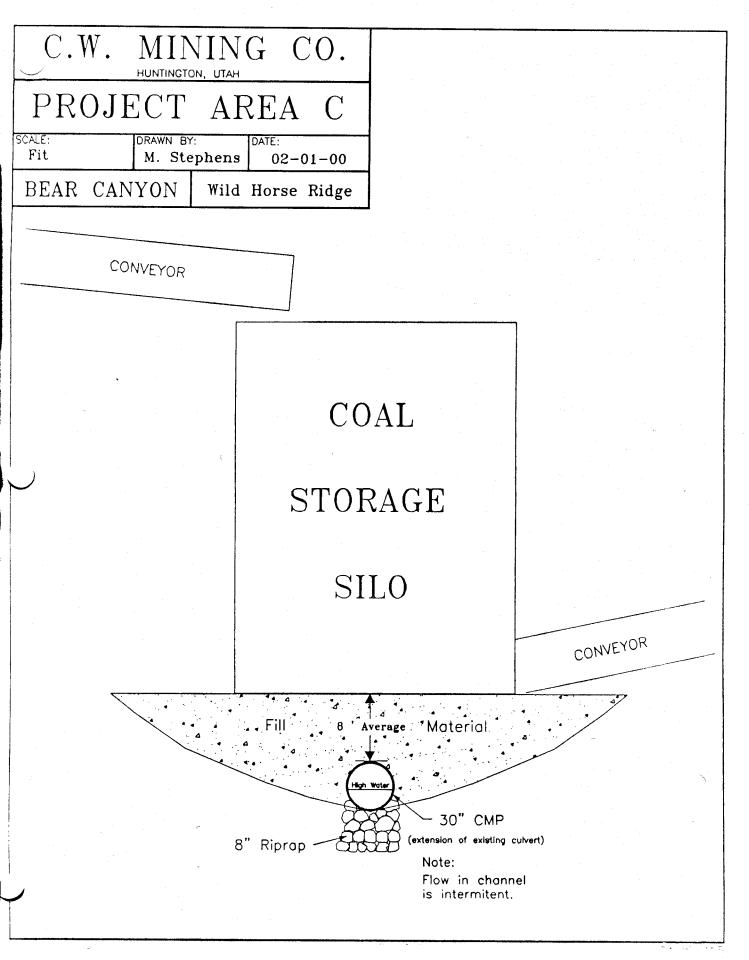Worksheet Name: CULVERT C-26U

Comment: SEE PLATE 7-1G

Solve For Actual Depth


Given	Input Data: Diameter Slope	2.50 ft 0.0600 ft/ft 0.024
	Manning's n Discharge	19.69 cfs

Computed Results:

Depth	1.04 ft
Velocity	10.19 fps
Flow Area	1.93 sf
Critical Depth	1.51 ft
Critical Slope	0.0172 ft/ft
Percent Full	41.59 %
Full Capacity	54.42 cfs
OMAX @.94D	58 54 CIS
	2.03 (flow is Supercritical
Froude Number	

Minimum required riprap conditions = 8" m.d. riprap at outlet

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C.W. MINING CO.

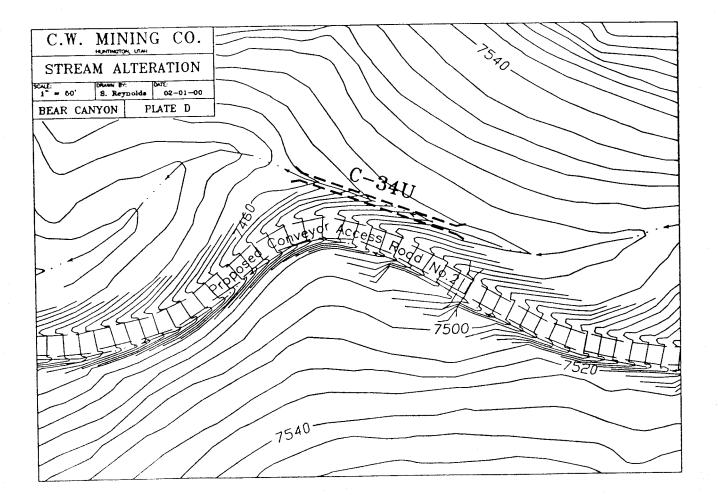PROJECT AREA D


SCALE: DRAWN BY:


Fit M. Stephens

02-01-00

BEAR CANYON

Wild Horse Ridge

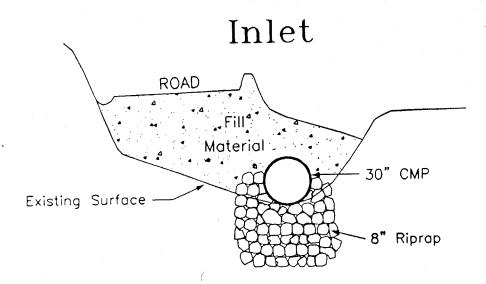

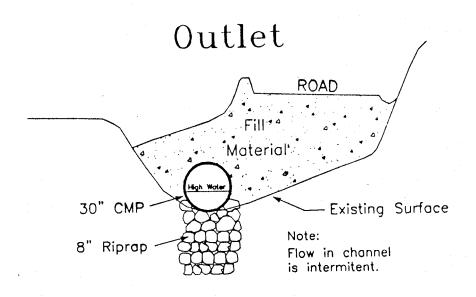

Circular Channel Analysis & Design Solved with Manning's Equation

Open Channel - Uniform flow

Worksheet Name: CULVERT C-34U

Comment: SEE PLATE 7-1G

Solve For Actual Depth

Given Input Data:

 Diameter
 2.50 ft

 Slope
 0.0600 ft/ft

 Manning's n
 0.024


 Discharge
 17.86 cfs

Computed Results:

QMAX @.94D...... 58.54 cfs Froude Number.... 2.04 (flow is Supercritical)

Minimum required riprap conditions = 8" m.d. riprap at outlet

Open Channel Flow Module, Version 3.3 (c) 1991 Haestad Methods, Inc. * 37 Brookside Rd * Waterbury, Ct 06708

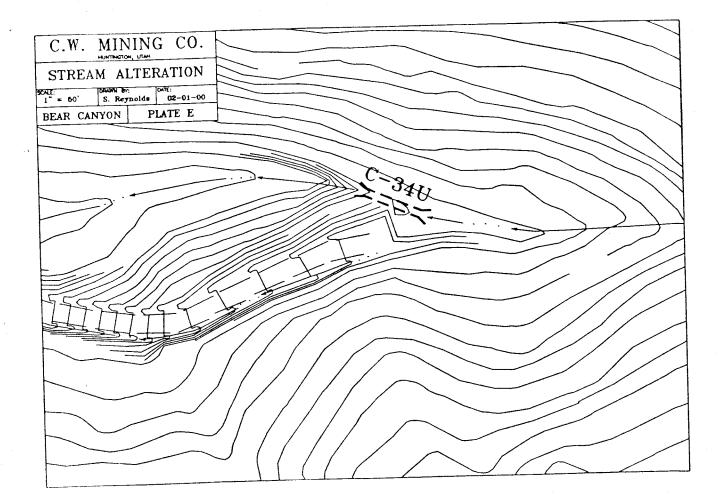

C.W. MINING CO. PROJECT DRAWN BY:


SCALE: M. Stephens Fit


02-01-00

BEAR CANYON

Wild Horse Ridge

Inlet

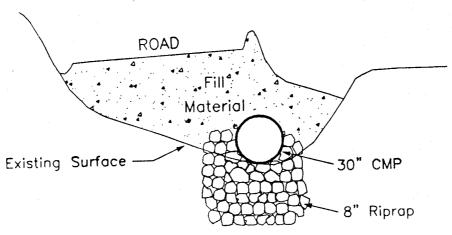

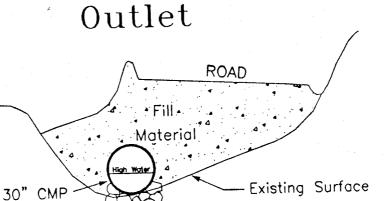

8" Riprap

Note: Flow in channel is intermitent.

Circular Channel Analysis & Design Solved with Manning's Equation

Open Channel - Uniform flow

Worksheet Name: CULVERT C-34U

Comment: SEE PLATE 7-1G

Solve For Actual Depth

Given Input Data:

 Diameter
 2.50 ft

 Slope
 0.0600 ft/ft

 Manning's n
 0.024


 Discharge
 17.86 cfs


Computed Results:

QMAX @ 94D..... 58.54 cfs Froude Number.... 2.04 (flow is Supercritical)

Minimum required riprap conditions = 8" m.d. riprap at outlet

Open Channel Flow Module, Version 3.3 (c) 1991 Haestad Methods, Inc. * 37 Brookside Rd * Waterbury, Ct 06708

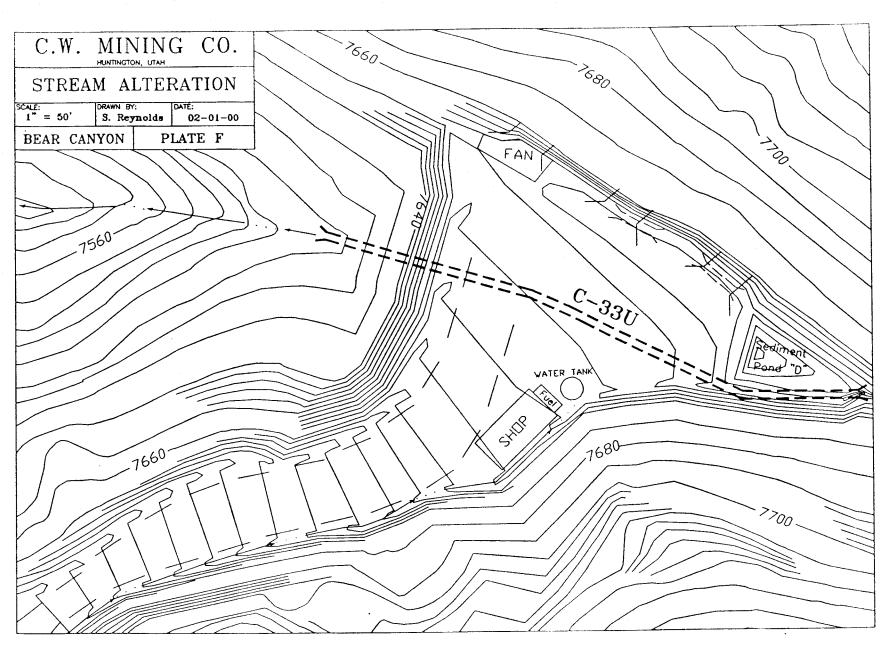

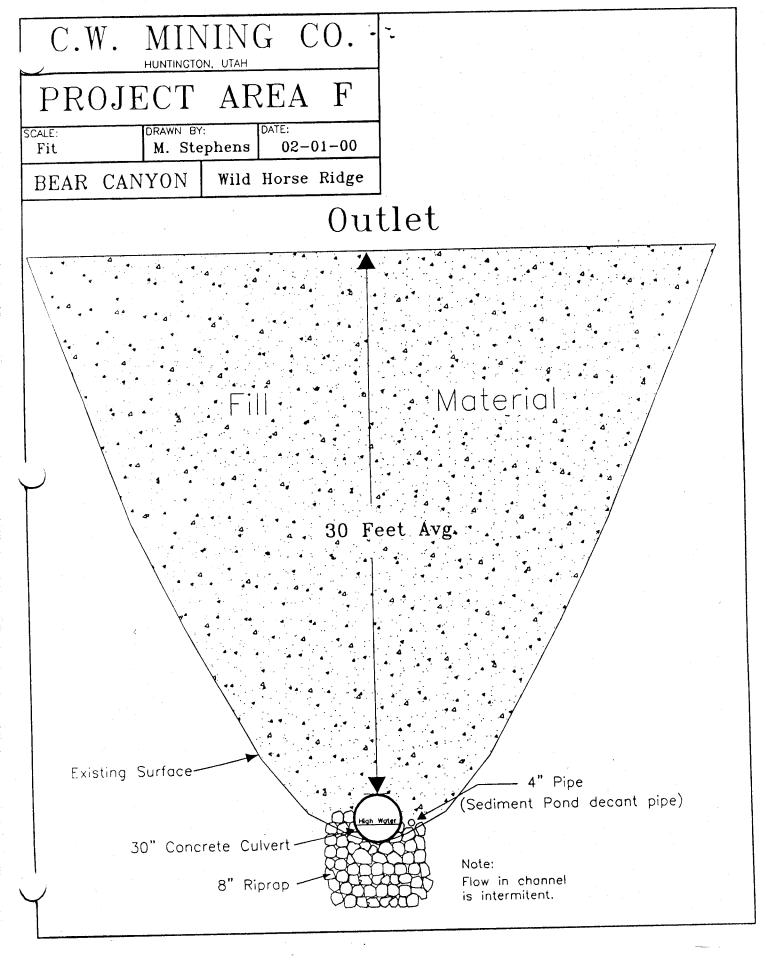

Circular Channel Analysis & Design Solved with Manning's Equation

Open Channel - Uniform flow

Worksheet Name: CULVERT C-33U

Comment: SEE PLATE 7-1G

Solve For Actual Depth

Computed Results:

Results.	0.88 ft	
Depth		
Velocity	9.37 fps	
Flow Area	1.54 sf	
Critical Depth	1.28 ft	
Critical Slope	0.0156 ft/ft	
Percent Full	35.14 %	
Full Capacity	54.42 cfs	
	58.54 cfs	
QMAX @.94D	50.54 CLB	1.5
Froude Number	2.06 (flow is Supercritication	 /

Minimum required riprap conditions = 8" m.d. riprap at outlet

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DIVISION OF WATER RIGHTS

Michael O. Leavitt Governor Kathleen Clarke Executive Director Robert L. Morgan State Engineer 801-538-7467 (Fax)

1594 West North Temple, Suite 220 PO Box 146300 Salt Lake City, Utah 84114-6300 801-538-7240

April 10, 2001

Charles Reynolds Co-op Mining Company P.O. Box 1245 Huntington, UT 84528

Stream Channel Alteration Permit Number 00-93-01SA for placement of culverts on Bear RE: Creek and on the right fork of Bear Creek in Emery County.

EXPIRATION DATE: April 10, 2002

Your application to Alter a Natural Stream Channel Number 00-93-01SA is hereby approved pursuant to the requirements of Section 73-3-29 of the Utah Code Annotated, 1953. This approval also constitutes compliance with Section 404 (e) of the Clean Water Act (33 USC 1344) pursuant to General Permit 040 issued to the State of Utah by the U.S. Army Corps of Engineers on October 15, 1987.

Work performed under this permit is subject to the following conditions:

- The expiration date of this approved application is April 10, 2002. The expiration date 1. may be extended, at the State Engineer's discretion, by submitting a written request outlining the need for the extension and the reasons for the delay in completing the proposed stream alteration.
- A copy of this approved permit must be kept on-site at any time the work under this 2. approved permit is in progress.
- Culverts shall be placed at locations that will minimize the possibility of washouts. Areas 3. adjacent to meanders must be avoided as water may be directed toward the edges, rather than the center of the culvert. Culverts must be placed at GRADE and create no change in the profile of the stream bottom to avoid upstream erosion. Fill, adjacent to the culvert, must be adequately compacted to prevent piping and washout of the crossing. Particular attention should be shown to the outlet of the Bear Creek culvert.
- Impacts to the stream channel and surrounding environment must be minimized. 4. Vegetation should not be destroyed, but if some disturbance is necessary, then revegetating with native species will be required, especially of woody shrubs. The channel contours and configuration must not be changed except in the case of bank contouring for stabilization purposes.

- 5. Work must be accomplished during a period of low flow. Sediment introduced into stream flows during construction must be controlled to prevent increases in turbidity downstream. Flows must be diverted away from the construction area using a non-erodible coffer dam.
- 6. Excavated material and construction debris may <u>not</u> be wasted in any stream channel or placed in flowing waters, this will include material such as grease, oil, joint coating, or any other possible pollutant. Excess materials must be wasted at an upland site well away from any channel. Construction materials, bedding material, excavated material, etc. may not be stockpiled in riparian or channel areas.
- Riprap must consist of only clean, properly sized, angular rock. Riprap must be keyed deeply into the stream bed to prevent undercutting. A filter shall be placed behind riprap if necessary (i.e., if soils are fine grained, non-cohesive, and/or erodible). Demolition debris or refuse will not be allowed, nor material such as bricks, concrete, asphaltic material [either natural (tar sand, oil shale, etc.) or man made].
- 8. Erosion control measures and revegetation success must be monitored and reported to this office prior to the compliance inspection.
- 9. Removal of culverts as part of the reclamation process must follow Best Management Practices.
- 10. Culverts must be designed to withstand depth of fill, buildings, and construction activities. Methods such as use of concrete encased pipes may need to be utilized, especially for culverts shown on plates F and C.
- Approval of this application does not authorize trespass, easements, rights-of-way, or any other access or land use permits. It is the responsibility of the applicant to obtain any such authorizations as may be necessary for this proposal.
- Within 30 days after the completion of this project, the State Engineer's office must be contacted for a compliance inspection. Failure to provide such notification would invalidate U.S. Army Corps of Engineers General Permit 040, thereby placing the applicant in violation of Section 404 of the Clean Water Act.

This Decision is subject to the provisions of Rule R655-6 of the Division of Water Rights and to Sections 63-46b-13 and 73-3-14 of the Utah Code Annotated, 1953 as amended, which provide for filing either a Request for Reconsideration with the State Engineer, or an appeal with the appropriate District Court. A Request for Reconsideration must be filed with the State Engineer within 20 days of the date of this decision. However, a Request for Reconsideration is not a prerequisite for a court appeal. A court appeal must be filed within 30 days after the date of this Decision, or if a Request for Reconsideration has been filed, within 30 days after the date the Request for Reconsideration is denied. A Request for Reconsideration is considered denied when no action is taken 20 days after the Request is filed.

Page 3 00-93-01SA April 10, 2001

If you have any questions or need further clarification, please contact Daren Rasmussen at 801-538-7377.

Sincerely,

Robert L. Morgan, P.E.

State Engineer

RLM/dr/jm

pc: Mike Sch

Mike Schwinn - Corps of Engineers

Dave Ruiter - EPA

Field Supervisor - U.S. Fish & Wildlife

Jim Dykmann - State History Carolyn Wright - State Planning Mark Page - Regional Engineer

Derris Jones - Regional Wildlife Habitat Manager Bill Bradwisch - Aquatic Habitat Coordinator

JOINT PERMIT APPLICATION FORM

U. S. ARMY CORPS OF ENGINEERS - FOR SECTIONS 404 AND 10 UTAH STATE ENGINEER'S OFFICE - FOR NATURAL STREAM CHANNELS

Application Number (Assigned by:)	Corps	<u> </u>	State Engineer	
Applicant's Name (Last, First M.I.) CO-OP Mining Company		Authorized Agent Charles Reynolds	Telephone 1 (435) 6	Number and Area Code 87-2450
Applicant's Address (Street, RFD, Box Nu	ımber, City, State, Zip)			
P.O. Box 1245 Huntington Ut	tah, 84528			/
		JECT LOCATION		
Quarter Section(s)	Section	Township	Range	Base & Meridian
A,B = SW1/4 $C = SE 1/4$	24	Ť16S	R7E	SLBM
County	Watercourse to be a Bear Creek, Ri	La Danie		Outside city limits Huntington
Project location or address:				
Bear Canyori Mine, Bear Cany	on on			
Brief description of project:				
Purpose (justification) of project: Construction of Additional Fa	acilities			
is this a single and complete project or is project or other related activities. This project is part of the W				o, please describe the larg
It project includes the discharge of dredg	ged or fill material:			
Cubic yards of material:	N/A			
Acreage or square footage of	waters of the United Sta	ates, including wetlands, affo	ected by the project:	
Source and type of fill materi	al:			


		• 1	1.1	·		· ·		
Alternatives (o	other ways to acco	omplish the project p	ourpose):	•				
None								
						· · ·		
Names and add	dresses of adjace	nt property owners o	r other individuals	who may be	affected by t	his project:		
C.O.P. C		ment Co. (Surfa	ace Landowne	r)				
Salt Lake	e City, Ut. 84							
authorizations.		ed by Federal, state					gram), and the sta	itus of those
Approva Applicat	I from Utah S ion is current	State Division of ly under review	i Oii, Gas & N	mmig (AC	.17013702	.		
Estimated star	ting date of proje	ect		Estimated co	ompletion da	ite		
8-15				8-	29-01			
Application is	hereby made for	ready been partially or r a permit or permits and that to the best of rtake the proposed ac	to authorize the a	ctivities descri	ibed herein.	I certify that is true, comp	t I am familiar wi	th the information
			Signature of app	licant				Date
					٠.			
Thereby certi	fy that	· · · · · · · · · · · · · · · · · · ·		is	acting as m	y agent for the	nis project.	
Agent's addre	ess and telephone	number						


INSTRUCTIONS

Applications which do not include the following will not be processed.

For a complete application, you MUST include the following on 8 1/2 by 11 paper (for large projects, multiple sheets with a key may be used). Clear, hand-drawn plans approximately to scale are acceptable.


- 1. An accurate location map (USGS quadrangle map preferred)
- 2. A plan view of the proposed activity (as seen from above) including dimensions of work.
- 3 A cross-section view of the proposed activity (may use typical cross-section for large projects) including dimensions
- 4 For projects which include wetlands, an accurate wetland delineation must be prepared in accordance with the current method required by the Corps.

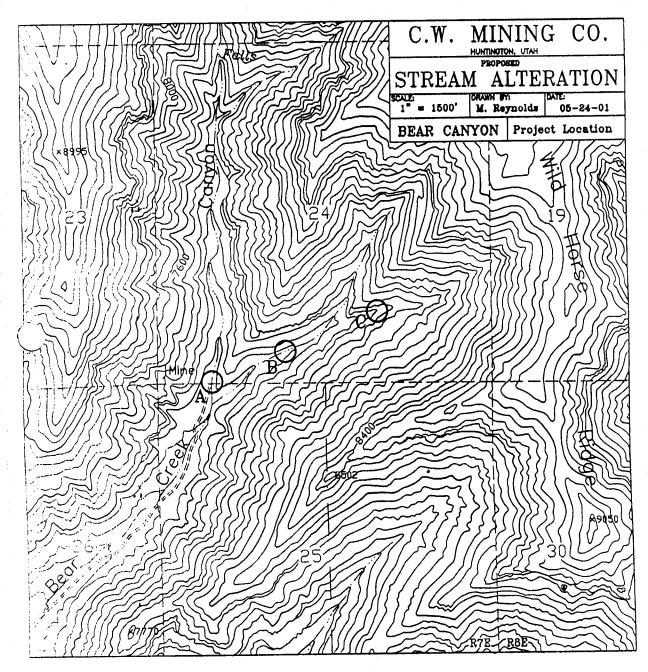

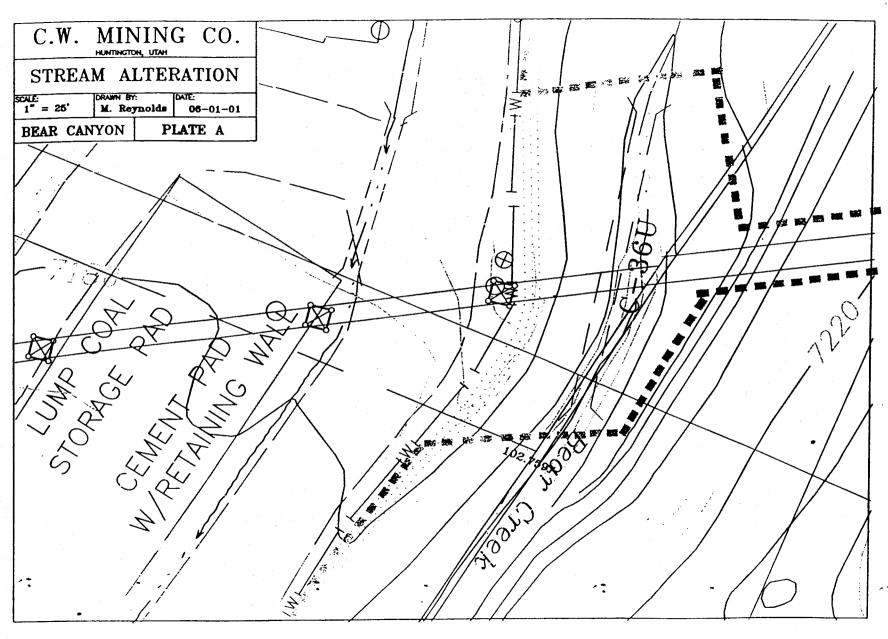


C.W. MINING CO. HUNTINGTON, UTAH PROJECT AREA A SCALE: Not To Scale DRAWN BY: Not To Scale M. Reynolds DATE: Not To Scale M. Reynolds 05-24-01 BEAR CANYON BEAR Creek Culvert Addition

Inlet

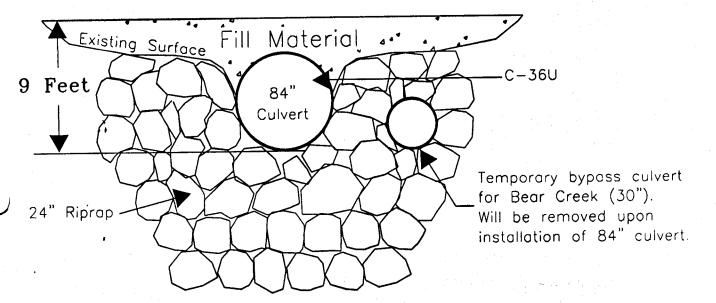



Outlet

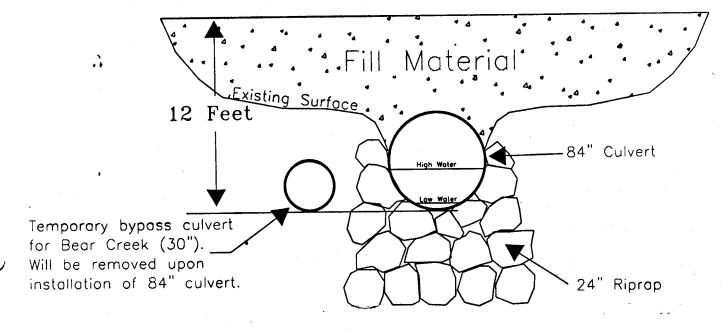



Worksheet **Worksheet for Circular Channel**

Project Description	
Worksheet	C-36U
Flow Element	Circular Channel
Method	Manning's Formula
Solve For	Channel Depth
• •	
Input Data	
Mannings Coefficient	0.024
Slope	0.060000 ft/ft
Diameter	84 in
Discharge	412.70 cfs
Results	
Depth	3.45 ft
Flow Area	18.9 ft²
Wetted Perimeter	10.89 ft
Top Width	7.00 ft
Critical Depth	5.35 ft
Percent Full	49.2 %
Critical Slope	0.016383 ft/ft
Velocity	21.88 ft/s
Velocity Head	7.44 ft
Specific Energy	10.88 ft
Froude Number	2.35
Maximum Discharç	911.73 cfs
Discharge Full	847.56 cfs
Slope Full	0.014226 ft/ft
Flow Type	Supercritical

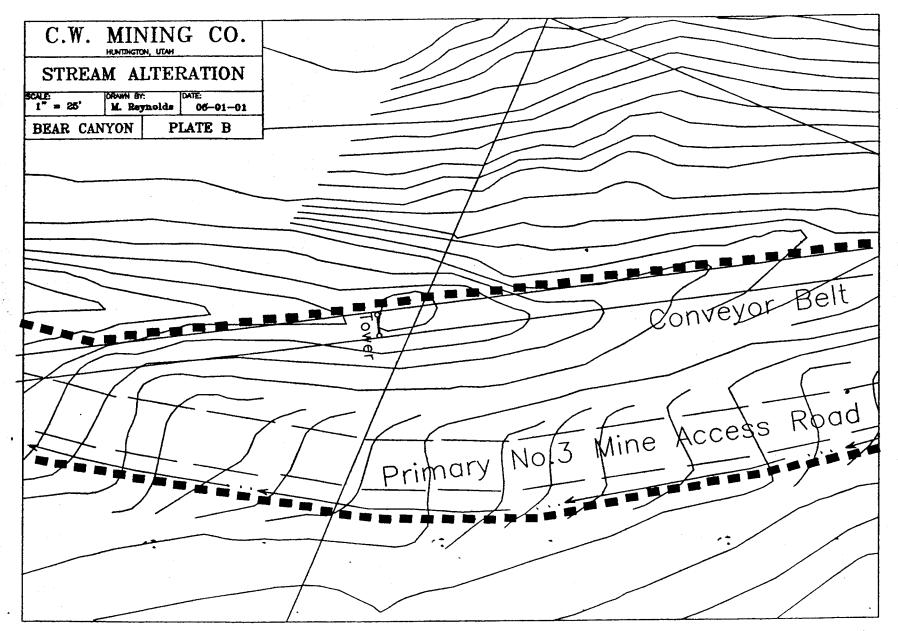

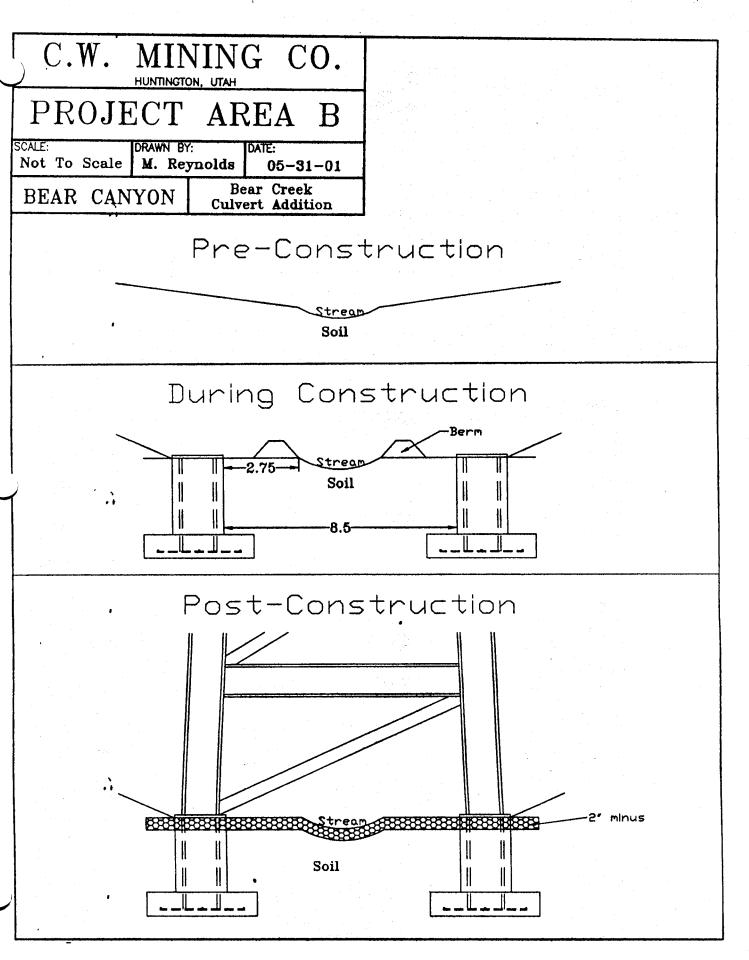

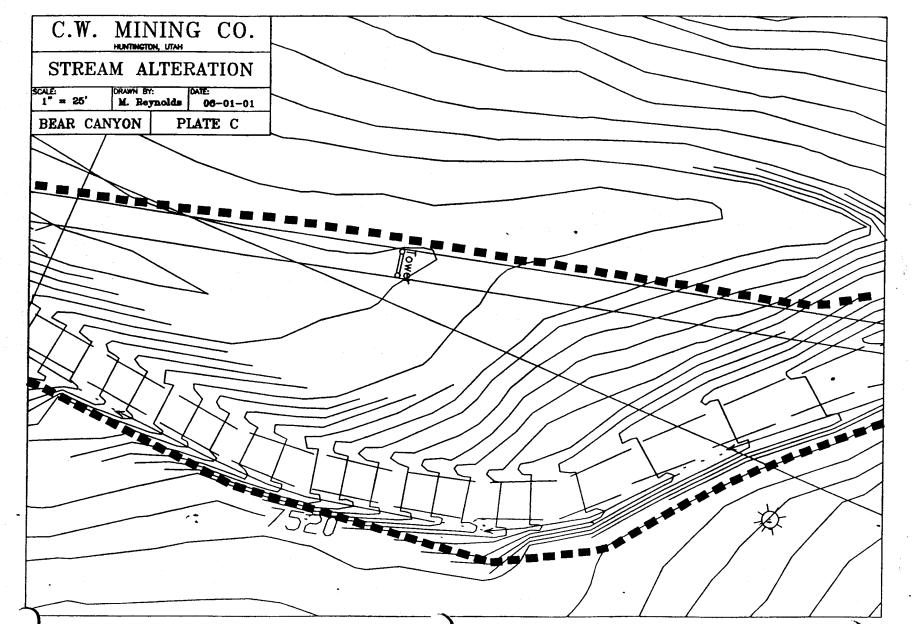

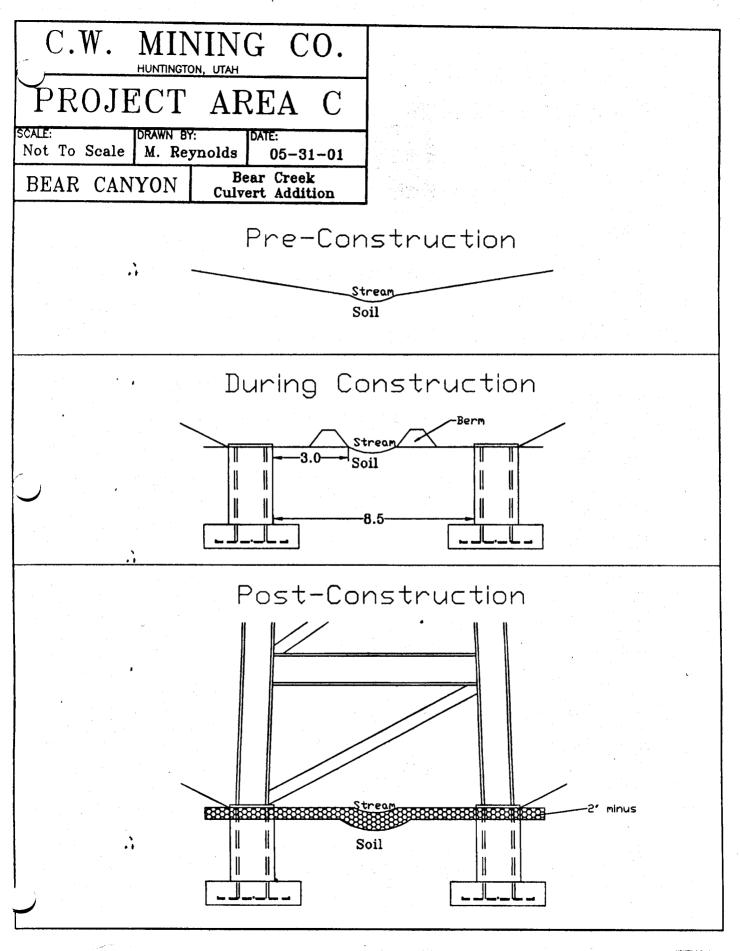



DEPARTMENT OF NATURAL RESOURCES DIVISION OF WATER RIGHTS

August 28, 2001

Michael O. Leavitt Covernor Kathleen Clarke Executive Director

1594 West North Temple, Suite 220 PO Box 146300 Salt Lake City, Utah 84114-6300 801-538-7240 Robert L. Morgan State Engineer 801-538-7240 801-538-7467 (Fax)

Charles Reynolds CO-OP Mining Coming P.O. Box 1245 Huntington, UT 84528

RE: Stream Channel Alteration Permit Number 01-93-07SA for mining construction and culvert placement on the right fork of Bear Creek in Emery County. EXPIRATION DATE: August 28, 2002

Your application to Alter a Natural Stream Channel Number 01-93-07SA is hereby approved pursuant to the requirements of Section 73-3-29 of the Utah Code Annotated, 1953. This approval also constitutes compliance with Section 404 (e) of the Clean Water Act (33 USC 1344) pursuant to General Permit 040 issued to the State of Utah by the U.S. Army Corps of Engineers on October 15, 1987.

Work performed under this permit is subject to the following conditions:

- The expiration date of this approved application is August 28, 2002. The expiration date 1. may be extended, at the State Engineer's discretion, by submitting a written request outlining the need for the extension and the reasons for the delay in completing the proposed stream alteration.
- A copy of this approved permit must be kept on-site at any time the work under this 2. approved permit is in progress.
- Work must be done during low flows. Any flow at the time of construction must be 3. bypassed as proposed on the drawings. This project must be done in a way to limit added sedimentation, hydrocarbons, and coal fines into the stream.
- A sufficient length of culvert must be installed to allow for stable slopes on the fill over 4. the culvert.
- Erosion and sediment control measures must be implemented, monitored, and success 5. reported prior to the compliance inspection to minimize the impact to Bear and Huntington Creeks.
- Sites B and C are on dry channels, but best management practices must be employed to 6. maintain occasional flood flow events.
- All sites must be vegetated with appropriate grasses and woody vegetation. Proper stream 7. form and function must be restored and vegetation success reported prior to the compliance inspection. Also, plans for reclamation of the stream, once mining is completed, must be addressed in the Utah Division of Oil, Gas, and Mining documentation (CO-OP Mine Plans).

- 8. Excavated material and construction debris may <u>not</u> be wasted in any stream channel or placed in flowing waters, this will include material such as grease, oil, joint coating, or any other possible pollutant. Excess materials must be wasted at an upland site well away from any channel. Construction materials, bedding material, excavated material, etc. may <u>not</u> be stockpiled in riparian or channel areas. Equipment must also be cleaned and fueled outside of the riparian area.
- 9. Approval of this application'does not authorize trespass, easements, rights-of-way, or any other access or land use permits. It is the responsibility of the applicant to obtain any such authorizations as may be necessary for this proposal.
- 10. Within 30 days after the completion of this project, the State Engineer's office must be contacted for a compliance inspection. Failure to provide such notification would invalidate U.S. Army Corps of Engineers General Permit 040, thereby placing the place applicant in violation of Section 404 of the Clean Water Act.

This Decision is subject to the provisions of Rule R655-6 of the Division of Water Rights and to Sections 63-46b-13 and 73-3-14 of the Utah Code Annotated, 1953 as amended, which provide for filing either a Request for Reconsideration with the State Engineer, or an appeal with the appropriate District Court. A Request for Reconsideration must be filed with the State Engineer within, 20 days of the date of this decision. However, a Request for Reconsideration is not a prerequisite for a court appeal. A court appeal must be filed within 30 days after the date of this Decision, or if a Request for Reconsideration has been filed, within 30 days after the date the Request for Reconsideration is denied. A Request for Reconsidered denied when no action is taken 20 days after the Request is filed.

If you have any questions or need further clarification, please contact Daren Rasmussen at 801-538-7377.

Sincerely,

Robert L. Morgan, P.E.

State Engineer

RLM/dr/jm

pc: Corps of Engineers
Dave Ruiter - EPA
Field Supervisor - U.S. Fish & Wildlife
Jim Dykmann - State History
Carolyn Wright - State Planning
Mark Page - Regional Engineer
Derris Jones - Regional Wildlife Habitat Manager
Bill Bradwisch - Aquatic Habitat Coordinator

After further evaluation C.W. Mining Co. elected not to alter the stream in Area A. The stream was never culverted in this location and culvert C-36U is located in a different area.